For Sale or Lease

3300 Power Inn Road Sacramento, CA 95826



Jim Sullivan

Phone: 916-361-8500 Cell: 916-730-6200 sullivangroupre@aol.com

DRE Lic. 01883524

Sullivan Group Commercial Real Estate

6720 Folsom Blvd., Suite 208 Sacramento, CA 95819 Phone: 916-361-8500 Fax:916-361-8900 www.sullivangroupre.com



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Granite Regional Park 3 million SQ FT office accross the street

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Located at the corner of Power Inn Road & Cucamongo Ave

- Located on the soon to open estimated August 2018 direct route into the CSUC campus
- Existing 8,400 +/- SQ FT free span concrete tilt-up warehouse
- Easy access to Hwy 50
- Just a few steps to the Power Inn Road Light Rail Station & Bus Service
- ~1.67 acres or 72,745 SQ FT parcel
- Zoned MRD-SW
- Nearby Tenants include: Starbucks, Franchise Tax Board, Sac. County Public Administration, Sac. County Provate Court, Sac. County Child Suport,
- Large concrete yard area
- Excellent site for redevelopment path of future growth
- APN: 079-0282-027-0000

Jim Sullivan

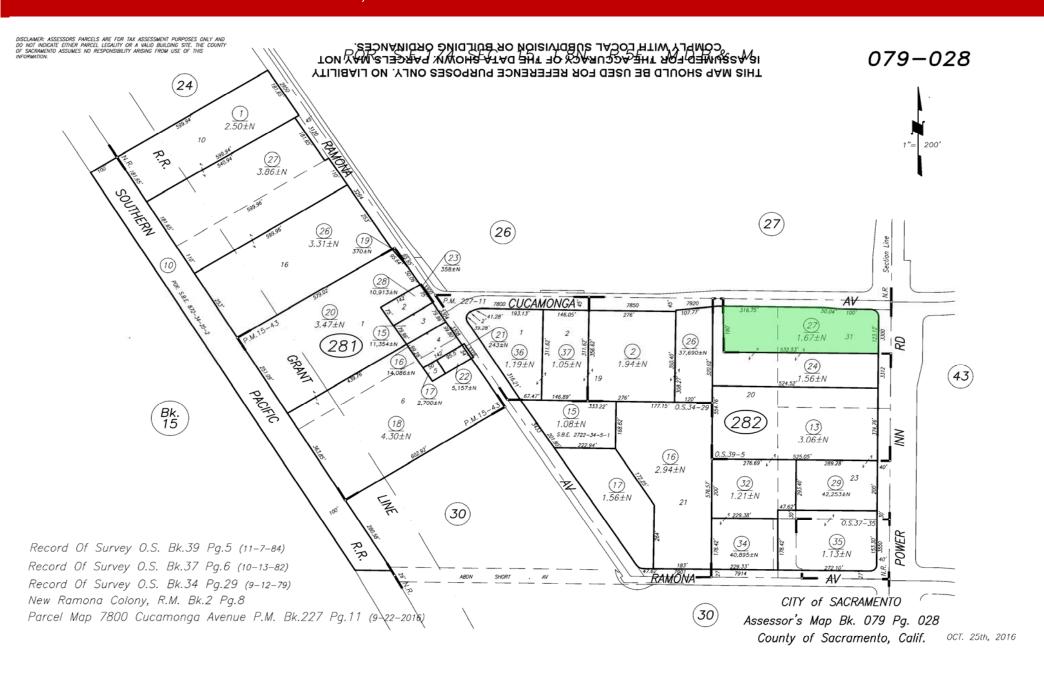
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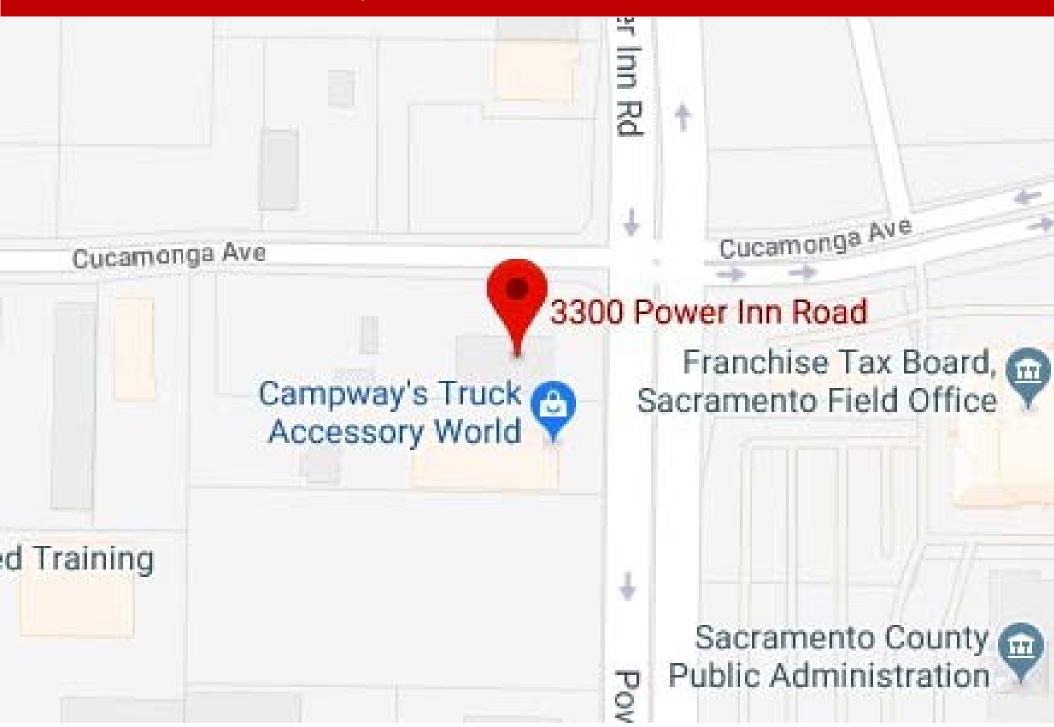
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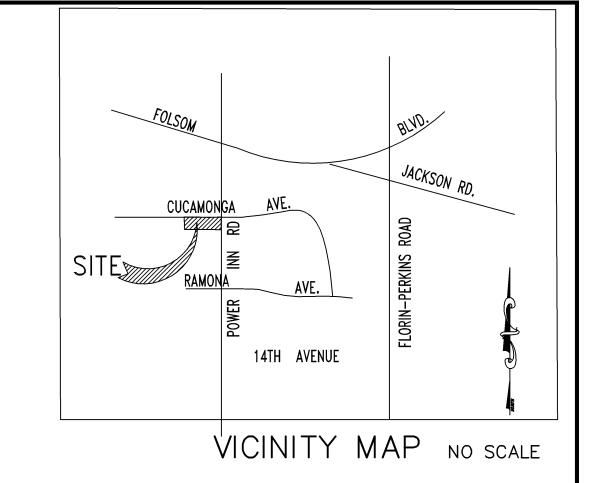
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- 1) NO PRELIMINARY TITLE REPORT WAS PROVIDED FOR THE PREPARATION OF THIS SURVEY.
- 2) THE POSITION OF IDENTIFIED RECORD EASEMENTS HAVE BEEN PLOTTED USING RECORD DESCRIPTIONS. SURFACE FACILITIES HAVE BEEN PLOTTED USING FIELD INFORMATION. THE ACTUAL LOCATIONS OF UNDERGROUND FACILITIES SHOULD BE VERIFIED PRIOR TO ANY NEW CONSTRUCTIONS.
- 3) THIS IS NOT A BOUNDARY SURVEY. ADDITIONAL FIELD SURVEY AND RESEARCH WILL BE REQUIRED TO ESTABLISHED THE ACTUAL BOUNDARY.
- THE TYPES, LOCATION, SIZES AND/OR DEPTHS OF EXISTING UNDERGROUND UTILITIES AS SHOWN ON THESE DRAWINGS WERE OBTAINED FROM SOURCES OF VARYING RELIABILITY. INTERESTED PARTIES ARE CAUTIONED THAT ONLY ACTUAL EXCAVATION WILL REVEAL THE TYPES, EXTENT, SIZES, LOCATIONS AND DEPTHS OF SUCH UNDERGROUND UTILITIES. JTS ENGINEERING CONSULTANTS, INC. ASSUMES NO RESPONSIBILITY FOR THE COMPLETENESS OR ACCURACY OF ITS DELINEATION OF SUCH UNDERGROUND UTILITIES NOR FOR THE EXISTENCE OF OTHER BURIED OBJECTS OR UTILITIES WHICH MAY BE ENCOUNTERED BUT WHICH ARE NOT SHOWN ON THESE DRAWINGS. PRESCRIPTIVE EASEMENTS MAY EXIST OVER THOSE FACILITIES WHICH ARE NOT WITHIN THE RECORD EASEMENT.
- 5) NO MONUMENTS WERE SET AS A PART OF THIS SURVEY. MONUMENTS WHICH WERE FOUND ARE SHOWN HEREON.

SURFACE IMPROVEMENT NOTES

- 1) ADA PARKING STALL WITH SIGNAGE
- 2 ADA PATH OF TRAVEL
- 3 PARKING STRIPE



 \circ **LEGEND** DRIVE-WAY DRIVE-WAY CUCAMONGA A VENUE DRAIN INLET WATER LINE DRAIN LINE SEWER LINE GAS LINE FIRE HYDRANT DRIVE-WAY DRIVE-WAY WATER VALVE DRIVE-WAY SEWER CLEAN OUT WATER METER S89°17'13"E SLIDING GATE FIRE DEPT. CONNECTION EDGE OF PAVEMENT EXISTING CHAIN LINK / FENCE WITH SLATS BACK FLOW PREVENTER CONCEPTUAL . PROP TANK PLANTING PLAN CONCRETE CURB CONCEPTUAL FOR PROPOSED EXISTING CHAIN LINK FENCE WITH SLATS SPOT ELEVATION PLANTING PLAN IRRIGATED FOR PROPOSEI PLANTER EXISTING CHAIN LINK , FENCE WITH SLATS TRAFFIC SIGNAL CONC. PAVED YARD PLANTER SEE CONCEPTUAL TRAFFIC SIGNAL WITH LIGHT PLANTING PLAN FOR PROPOSED IRRIGATED 23.74' SIGN PARKING LIGHT AC PAVING PULL BOX PLANTER RECYCLE EQUIPMENT CONVEYOR BELT GAS VALVE UTILITY POLE SHED GAS METER CONC. PAVED AREA — — (O.H.)— — OVER HEAD WIRE UTILITY POLE W/GUY PN:07 \square APN:079-0282-027 RECYCLE EQUIPMENT CONVEYOR BELT SHED ____X___X___X_ OVERHEAD DOOR SCALE: 1" = 20'GUARD POST EXIST BLDG RECYCLE EQUIPMENT BALER AND CONVEYOR BELT SHED TRANSFORMER RAIN WATER LEADER **₹WL** UNDEGROUND TELEPHONE LINE 492.53'
4' CONCRETE CINDER
BLOCK WALL UNDEGROUND ELECTRICAL EXISTING 8' HIGH CHAI LINK FENCE WITHOUT SLATS U.G. CABLE LINE RIDGE LINE AC PAVING CONC. PAVING APN:079-0282-024 APN:079-0282-024

S:\2008\2008-085\dwg\2008-085-SP.dwg, 12/5/2008 8:26:50 AM, JTS Engineering

BENCHMARK ELEVATION: 39.33'
CITY B.M.#319-D1E
HILTI NAIL LIGHT BASE NW CORNER FOLSOM
BLVD. AND BICENTENNIAL CIRCLE

FIELD BOOK NUMBER: PAGE:

JTSENGINEERING
CONSULTANTS, INC.
1808 J STREET
SACRAMENTO, CALIFORNIA 95811 (916) 441-6708

DESIGNED:	JTS	SCALE:	
DRAWN:	PHYA	H:1"=20'	
CHECKED:	JTS	<u>V:N/A</u>	
SUBMITTED:_	JAVED T. SIDDIQUI	RCE: 25924	

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TOPOGRAPHIC SURVEY/SITE PLAN

3300 POWER INN ROAD

APN: 079-0282-027

CITY OF SACRAMENTO